
## **BULK EARTHWORKS NOTES**

- THE CONTRACTOR IS TO FENCE THE LIMIT OF WORKS PRIOR TO THE PRE-START MEETING WITH COUNCIL.
- 2. EROSION AND SEDIMENT CONTROL MEASURES ARE TO BE INSTALLED PRIOR TO COMMENCEMENT OF CLEARING AND GRUBBING WORKS.
- 3. EXCAVATION AND FILLING IS TO BE CARRIED OUT TO THE PLAN LEVELS, DIMENSIONS AND BATTERS AS DRAWN. WORKS ARE TO BE GENERALLY IN ACCORDANCE WITH AS 3798 'GUIDELINES ON EARTHWORKS FOR COMMERCIAL AND RESIDENTIAL DEVELOPMENTS' & THE PROJECT GEOTECHNICAL REPORT, AS WELL AS THE LOCAL AUTHORITY STANDARDS.
- 4. ANY CLEARING REQUIRED TO BE UNDERTAKEN BY THE CONTRACTOR IS TO BE STRICTLY IN ACCORDANCE WITH THE COUNCIL APPROVED VEGETATION MANAGEMENT PLAN.
- 5. ALL SOILS CONTAINING ORGANIC AND DELETERIOUS MATTER IN THE TOPSOIL ZONE OF SOILS SHALL BE STRIPPED FROM THE CONSTRUCTION AREA. THIS MATERIAL IS NOT CONSIDERED SUITABLE FOR REUSE AS STRUCTURAL FILL. SOFT WET SOILS AND EXISTING FILL IS TO BE REMOVED PRIOR TO THE PLACEMENT OF STRUCTURAL FILL.
- 6. TREES ARE TO BE MULCHED & STOCKPILED ON SITE FOR USE WITH LANDSCAPING. WHERE PARTS OF TREES CANNOT BE MULCHED, THEY ARE TO BE REMOVED FROM SITE IN ACCORDANCE WITH LOCAL AUTHORITY REQUIREMENTS.
- 7. SLOPING GROUND SHOULD BE BENCHED TO 'KEY IN' FILL MATERIAL AND OPTIMIZE COMPACTION. THE BENCHES SHOULD SLOPE BACK AT 1V:10H AND BE AT LEAST 0.5m WIDE. WIDER BENCHES TO ACCOMMODATE THE WIDTH OF THE ROLLER MAY NEED TO BE ADAPTED IN SOME SITUATIONS. REFER FIGURE 1.
- 8. TOPSOIL APPROVED BY THE ENGINEER WHICH IS SUITABLE FOR REUSE IS TO BE CORRECTLY STOCKPILED ON SITE.
- 9. ALL OF THE SITE SHALL BE FREE DRAINING DURING ALL PHASES OF THE PROJECT IT IS THE CONTRACTORS RESPONSIBILITY TO PROTECT THE SITE AND SURROUNDING AREAS FROM DAMAGE RESULTING FROM STORWATER RUNOFF DURING CONSTRUCTION. DRAINAGE CONTROL DEVICES SUCH AS TEMPORARY DIVERSION DRAINS ARE TO BE IMPLEMENTED DURING CONSTRUCTION TO MINIMISE THE EFFECTS OF WEATHER.
- 10. UNLESS DIRECTED OTHERWISE BY THE SUPERINTENDANT ALL FILL SHALL BE PLACED AT BETWEEN +2% & -2% OF OPTIMUM MOISTURE CONTENT.

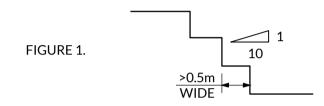

- 11. IN CONSTRUCTION AREAS, THE CLEARED AND STRIPPED GROUND SURFACE SHOULD BE PROOF ROLLED TO DETECT ANY SOFT OR LOOSE MATERIAL. LOOSE SOILS, SHOULD BE COMPACTED TO THE APPROPRIATE REQUIREMENTS. SOFT, WET CLAYS SHOULD PREFERABLY BE REMOVED. IN AREAS OF CUT, PROOF ROLLING MAY BE DEFERRED UNTIL AFTER THE CUT OPERATION. TEST ROLLING SHALL BE DONE WITH A SMOOTH DRUM ROLLER WITH MINIMUM STATIC WEIGHT OF 12 TONNE. THE TYNED NATURAL FOUNDATION SOIL SHALL BE COMPACTED TO A MINIMUM DENSITY INDEX OF 65% (SANDS) OR MINIMUM DENSITY RATIO OF 75% STANDARD (CLAYS).
- 12. ANY IMPORTED FILL, IF NEEDED TO MAKE UP EARTHWORK DEFICIENCIES, SHOULD BE OF FAIR TO GOOD QUALITY PLACED IN 200 THICK MAXIMUM LOOSE LAYERS AND CONFORM TO THE FOLLOWING GENERAL SPECIFICATION:

  SOAKED CBR
  MINIMUM 10%
  LIQUID LIMIT
  MAXIMUM 40%

MAXIMUM AGGREGATE SIZE SHRINK/SWELLINDEX

75mm MAXIMI IM OF 1.0%

100

SHRINK/SWELL INDEX MAXIMUM

13. GUIDELINES FOR MINIMUM RELATIVE COMPACTION VALUES FOR INSITU SOILS AND IMPORTED FILL FOR THE BUILDING AND PAVEMENTS ARE PRESENTED IN THE FOLLOWING TABLE:

MINIMUM RELATIVE COMPACTION	
LOCATION	MINIMUM DRY DENSITY RATIO (%)
BUILDING AREA	98
PAVEMENT AREA:	
BASE COURSE	98
SUB BASE COURSE	98
a) >0.3m BELOW PAVEMENT SUBGRADE	95

# b) < 0.3m BELOW PAVEMENT SUBGRADE NOTES :

- 1. THE RECOMMENDED COMPACTIONS ARE PERCENTAGES OF THE MAXIMUM DRY DENSITY DETERMINED BY AS 1289 5.1.1, (STANDARD)


  Output

  Description:
- COMPACTION).

  2. FOR PROCESSED PAVEMENT GRAVELS, MINIMUM DENSITY
  REQUIREMENTS SHOULD BE A PERCENTAGE OF MAXIMUM DRY DENSITY
  IN ACCORDANCE WITH AS 1289 5.2.1, (MODIFIED COMPACTION).
- 14. PRIOR TO THE USE OF ANY IMPORTED ENGINEERED FILL MATERIAL, THE CONTRACTOR SHALL NOMINATE SOURCE MATERIALS TO BE USED & PROVIDE TEST RESULTS OF ITS PROPERTIES FOR ITEMS SUCH AS PARTICLE SIZE DISTRIBUTION GRADINGS, LIQUID LIMIT, PLASTICITY INDEX etc. WHICH WOULD NORMALLY BE PERFORMED BY AN AUTHORIZED TESTING LABORATORY IN SATISFYING THIS REQUIREMENT. RESULTS SHALL BE SUBMITTED TO THE SUPERINTENDENT FOR APPROVAL PRIOR TO COMMENCING ANY WORKS.
- 15. STOCKPILED TOPSOIL IS TO BE RESPREAD TO AN EVEN 100mm THICKNESS OVER ALL BATTERS AND SURROUNDING EXPOSED AREAS. ANY EXCESS TOPSOIL IS TO BE DISPOSED OF BY THE CONTRACTOR OFF SITE (IF DIRECTED BY THE SUPERINTENDANT).
- 16. ANY EXCESS SPOIL MATERIAL GENERATED DURING CONSTRUCTION IS TO BE DISPOSED OF AS DIRECTED BY THE SUPERINTENDENT.


## **BULK EARTHWORKS NOTES**

- (CONT.)
  17. THE MOVEMENT OF MATERIAL TO AND FROM THE SITE SHALL BE IN
  ACCORDANCE WITH THE RELEVANT EPA GUIDELINES AND BIO-SECURITY
  REQUIREMENTS.
- 18. FOR FURTHER SITE INFORMATION REFER TO THE PROJECT GEOTECHNICAL CONSULTANT.
- 19. ALTERNATIVE METHODS OF CONSTRUCTION OTHER THAN THAT DESCRIBED ABOVE SHALL ONLY BE ALLOWED IF APPROVAL IS GIVEN BY THE SUPERINTENDENT.
- 20. DESIGN LEVELS PROVIDED ARE FINISHED SURFACE LEVELS (U.N.O)
- 21. ALL EARTHWORKS SHALL BE PERFORMED UNDER THE SUPERVISION OF A RECOGNIZED GEOTECHNICAL CONSULTANT TO LEVEL 1 STANDARDS SPECIFIED IN AS 3798 UNLESS DIRECTED OTHERWISE BY THE SUPERINTENDENT. ALL WORKS SHALL BE CERTIFIED BY A PROFESSIONAL ENGINEER. THE MINIMUM CERTIFICATION TO BE PROVIDED BY THE CONTRACTOR TO THE SUPERVISING ENGINEER SHALL BE:
- (i) CERTIFICATION THAT ALL GENERAL EARTHWORKS OPERATIONS (i.e. STRIPPING PROOF ROLLING OF SUBGRADE, ETC.) HAVE BEEN CARRIED OUT IN ACCORDANCE WITH THE EARTHWORKS SPECIFICATION.
- (ii) CERTIFICATION THAT FILL HAS BEEN PLACED AND COMPACTED TO REQUIRED MINIMUM DENSITY IN ACCORDANCE WITH THE EARTHWORKS SPECIFICATION.
- (iii) CERTIFICATION THAT THE CONTROLLED FILL IS SUITABLE FOR SUPPORT OF CONVENTIONAL HIGH LEVEL FOOTINGS AND HAS A MINIMUM BEARING CAPACITY OF 150kPa.
- (iv) CERTIFICATION THAT THE QUALITY OF ANY IMPORTED FILL COMPLIES WITH THE EARTHWORKS SPECIFICATION REQUIREMENTS.
- 22. FIELD DENSITY TESTING SHOULD BE CARRIED OUT TO CHECK THE STANDARD COMPACTION ACHIEVED AND THE PLACEMENT MOISTURE CONTENT. THE FREQUENCY AND EXTENT OF TESTING SHOULD BE AS PER GUIDELINES IN AS 3798
- 23. DEPRESSIONS FORMED BY THE REMOVAL OF VEGETATION, UNDERGROUND ELEMENTS ETC. SHOULD HAVE ALL DISTURBED WEAKENED SOIL CLEANED OUT AND BE BACKFILLED WITH COMPACTED SELECT MATERIAL.
- 24. ALL NEW WORKS TO MATCH NEATLY WITH EXISTING. THE CONTRACTOR IS TO CONFIRM THE LOCATION OF ALL EXISTING SERVICES AND PROTECT THESE SERVICES DURING CONSTRUCTION. DAMAGED SERVICES SHALL BE REPAIRED AT THE CONTRACTORS EXPENSE.

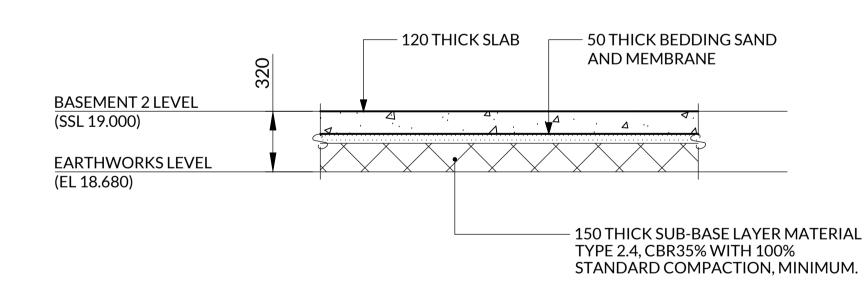

# **TYPICAL BASEMENT SECTION**


SCALE N.T.S.

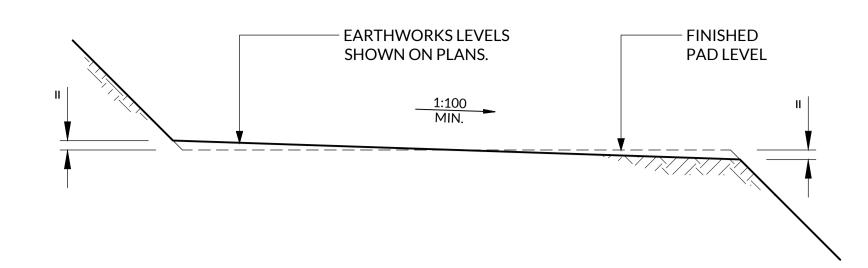

# TYPICAL BULK EARTHWORKS PAD CONSTRUCTION DETAIL

SCALE N.T.S.


NOTE: EARTHWORKS PLATFORMS ARE TO BE FORMED WITH MIN. 1:100 FALL ACROSS PAD DURING THE BULK EARTHWORKS PHASE. PLATFORMS TO BE TRIMMED TO FINISHED PAD LEVELS DURING DETAILED EARTHWORKS.

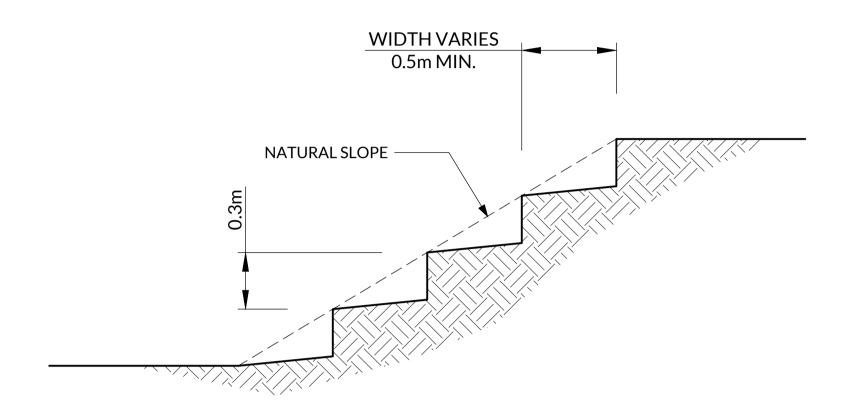

# **COMPACTION ON SLOPES DETAIL**

SCALE N.T.S.

NOTE: COMPACTION ON SLOPES GREATER THAN 1 IN 10 TO BE KEYED AS SHOWN UNLESS DIRECTED OTHERWISE BY THE GEOTECHNICAL ENGINEER.

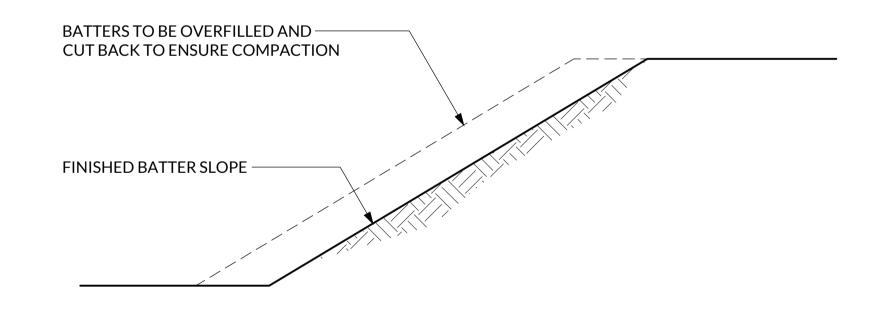

## BATTER CUTBACK DETAIL

SCALE N.T.S.

NOTE:

NO WORKS TO BE UNDERTAKEN OUTSIDE THE DESIGNATED SITE BOUNDARY UNLESS DIRECTED OTHERWISE BY THE MANAGING CONTRACTOR.

No.	DATE	AMENDMENT	BY
Α	29.09.21	PRELIMINARY ISSUE	C.R.P.
В	17.12.21	DA ISSUE	C.R.P.
l			

RP DESCRIPTION:

TRADERS IN PURPLE



e:admin@mrceng.com.au, www.mrceng.com.au

LAHC VILLAWOOD (BUILDINGS A & C) KAMIRA AVENUE VILLAWOOD, NSW 2163 Drawn: C.R.P. Date: AUG 2021

Designed: M.H. Checked: R.A.

Approved: M.H.

Status: FOR APPROVAL

Drawing TITLE:

BULK EARTHWORKS

NOTES AND DETAILS SHEET

Project No.


J21166

Drawing No.

C-1.01

Revision

B

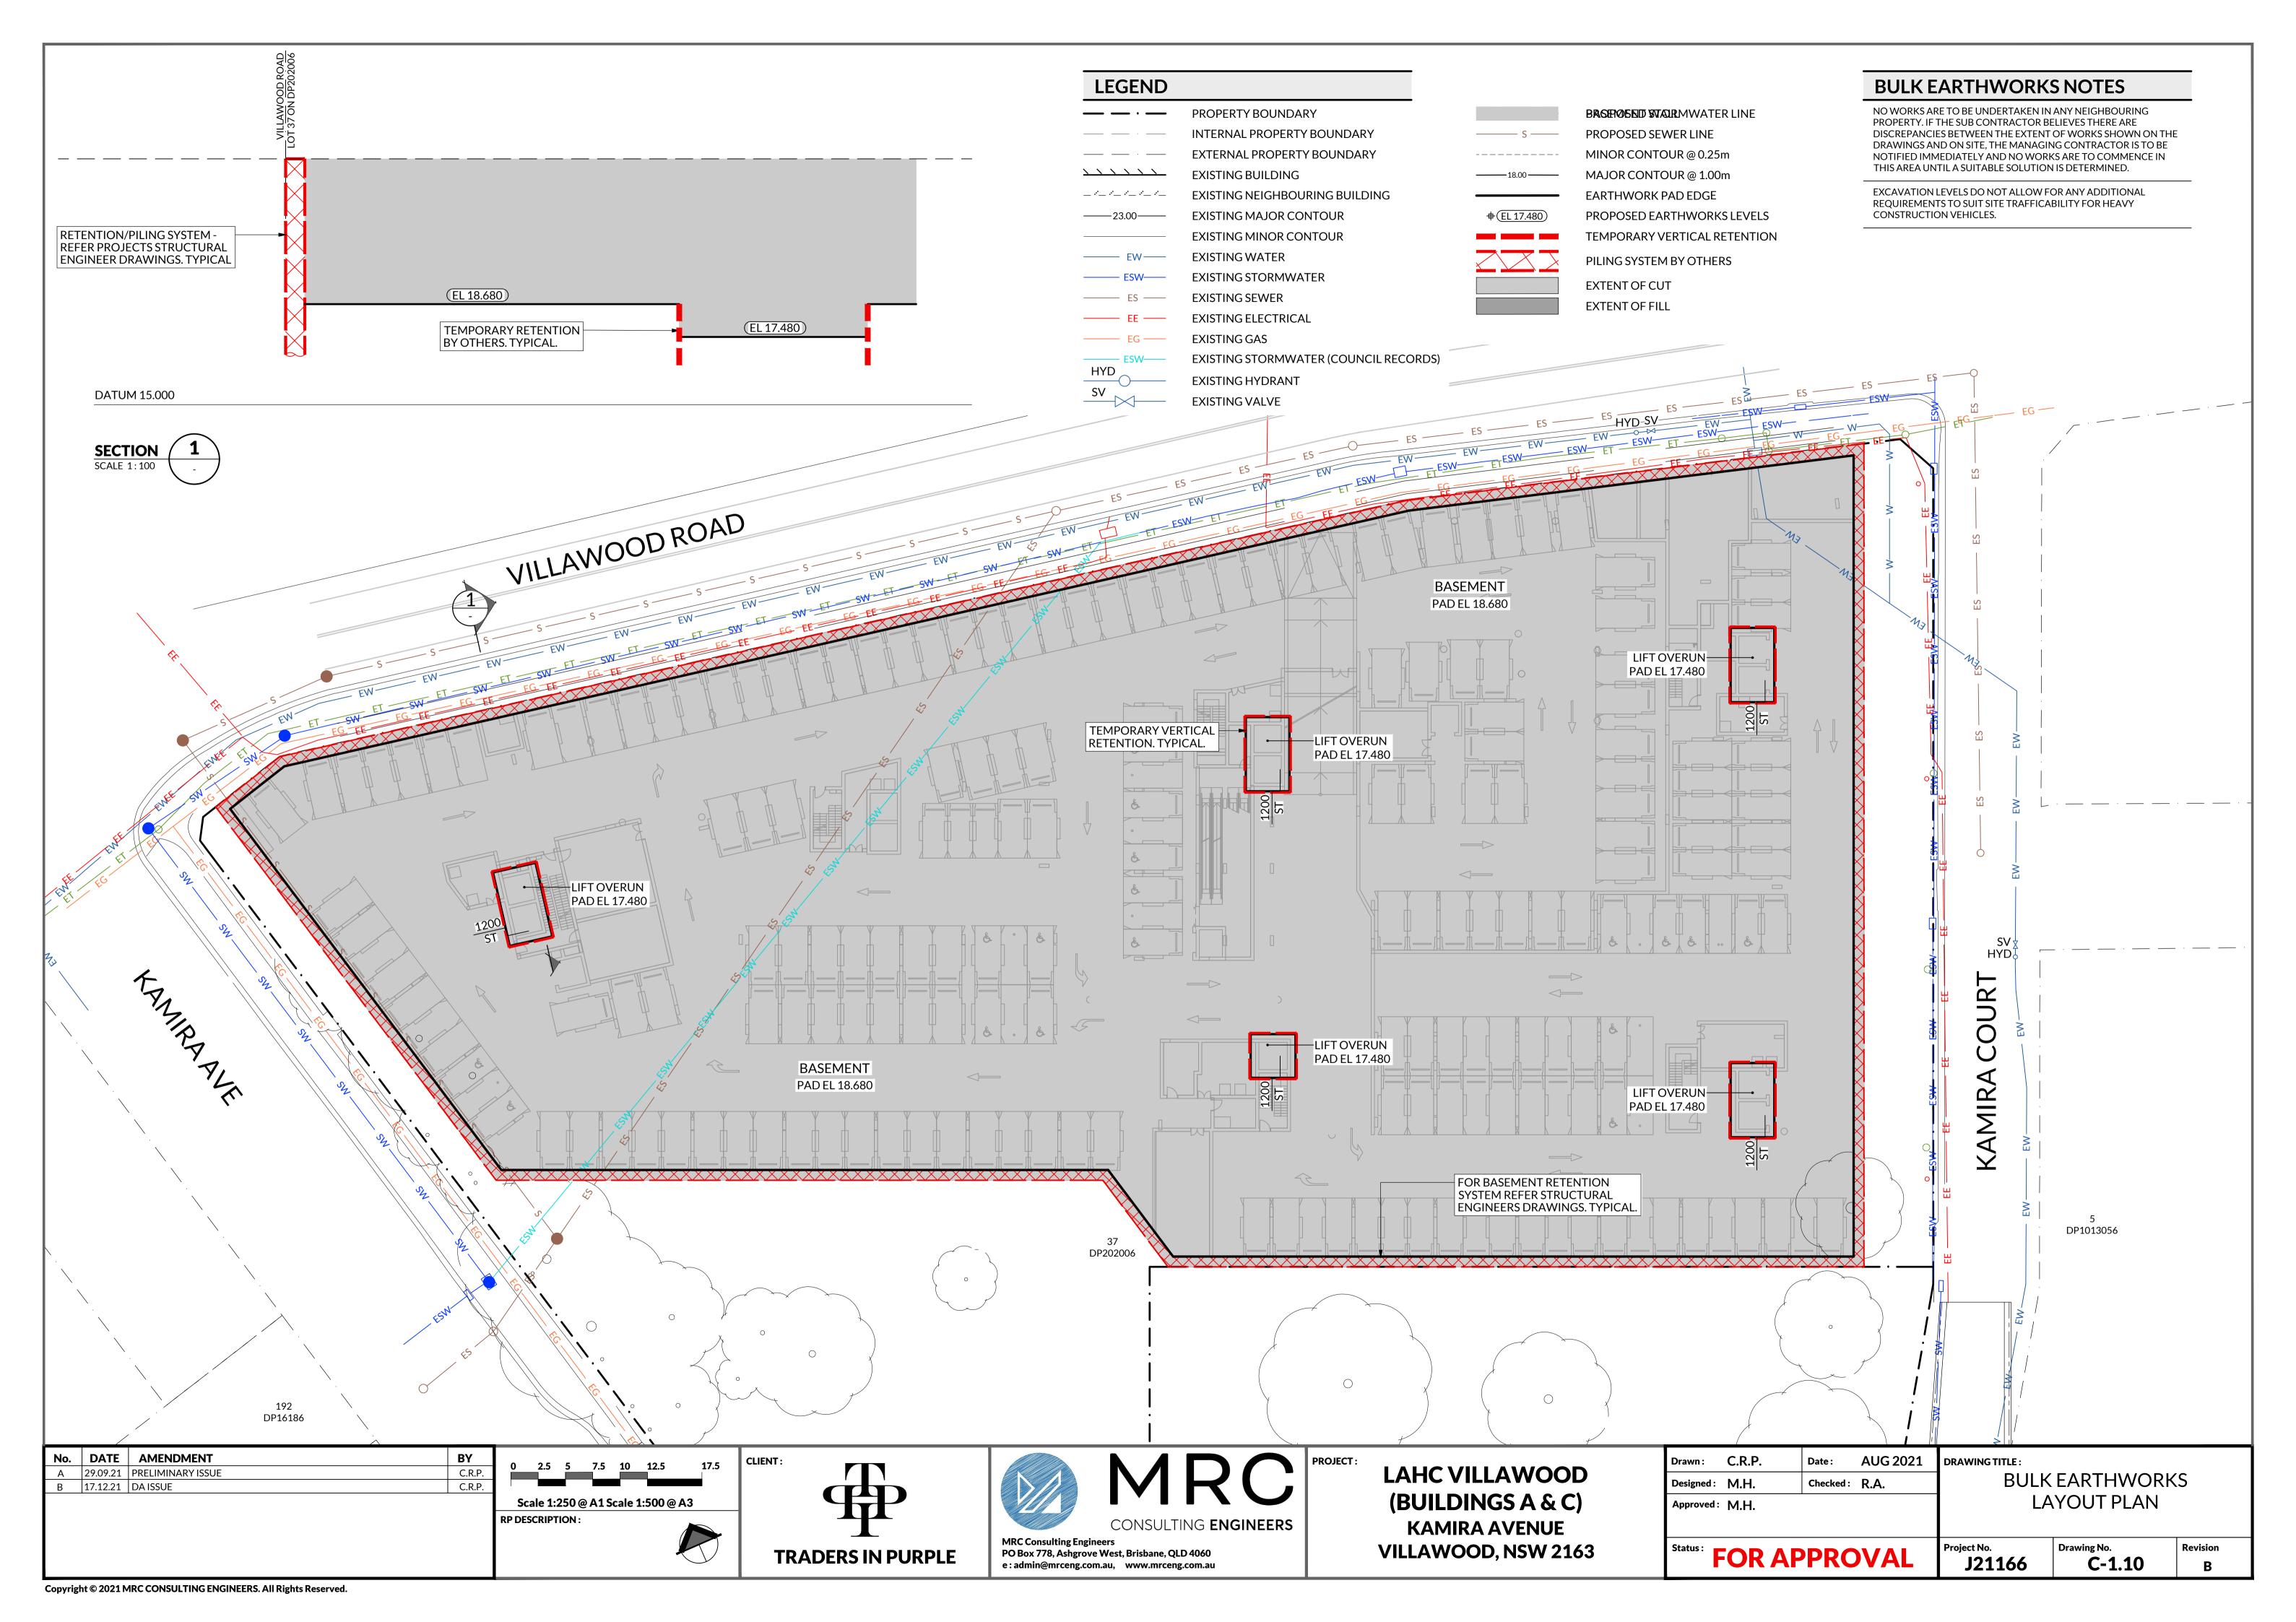

# **EROSION AND SEDIMENT CONTROL NOTES**

- ALL WORKS TO BE IN ACCORDANCE WITH DETAILS AS SHOWN ON PLAN, & TO THE SATISFACTION OF THE SUPERINTENDENT.
- CLEARING FOR EARTHWORKS OPERATIONS ARE TO BE MANAGED SUCH THAT AREAS NOT REQUIRED FOR IMMEDIATE WORKS ARE LEFT UNDISTURBED WHERE
- CONTROL DESIGN MEASURE SHALL BE INSTALLED IMMEDIATELY WHEN THE PROGRAM OF WORKS ON SITE PERMITS THE INSTALLATION.
- 4. THE CONTRACTOR SHALL REGULARLY CLEAN & MAINTAIN CONTROL MEASURES FOR THE DURATION OF WORKS & SHALL MONITOR THE EFFECTIVENESS OF THE EROSION & SEDIMENT CONTROL PLAN. ADEQUATE MEASURES SHALL BE TAKEN TO RECTIFY ANY FAILURE IN THE PROPOSED CONTROL SYSTEM WHERE SITE WORKS NECESSITATE THE PROVISION OF ADDITIONAL CONTROLS &/OR VARIATIONS TO EXISTING CONTROLS.
- 5. ALL SEDIMENT CONTROL STRUCTURES TO BE INSPECTED AFTER EACH RAINFALL EVENT FOR STRUCTURAL DAMAGE & ALL TRAPPED SEDIMENT TO BE REMOVED TO THE NOMINATED STOCKPILE SITE.
- 6. TEMPORARY CUT AND FILL BATTERS TO BE A GRADIENT OF 1V:2H MINIMUM.
- 7. TOPSOIL FROM DISTURBED AREAS TO BE STRIPPED & STOCKPILED ON SITE.
- AN ON-SITE REGISTER LOGGING RAINFALL DATES, WATER QUALITY ANALYSIS RESULTS. AND DATES OF RELEASE OF STORMWATER FROM THE SITE IS TO BE MAINTAINED. THIS REGISTER IS TO BE AVAILABLE ON-SITE FOR INSPECTION BY LOCAL AUTHORITY OFFICERS UPON REQUEST.

# SHAKEDOWN & WASHDOWN AREA NOTES

- SITE ACCESS MUST BE RESTRICTED TO THE MINIMUM PRACTICAL NUMBER OF
- SITE EXIT POINTS MUST BE APPROPRIATELY MANAGED TO MINIMISE THE RISK OF SEDIMENT BEING TRACKED ONTO SEALED, PUBLIC ROADWAYS.
- 3. SHAKE DOWN AREA TO BE 6.0M WIDE X 15M LONG MINIMUM CONSTRUCTED FROM 50-75mm NOMINAL SIZE, NON-FRIABI F/FRODIBLE ROCK, 200mm THICK UNDERLAID WITH "BIDIM A14" GEOFABRIC OR APPROVED EQUIVALENT
- ANY SEDIMENT LADEN VEHICLE EXITING THE SITE AS A RESULT OF WET WEATHER OR THE LIKE SHALL BE WASHED DOWN, CLEANED AND TREATED FIRST TO PREVENT SEDIMENT BEING DEPOSITED ONTO THE STREET. ANY SILT OR SEDIMENT TRACKED ONTO ROAD SHALL BE SWEPT UP AND COLLECTED. NO WASHING OF MATERIAL INTO COUNCIL DRAIN AREAS IS PERMITTED.
- 5. STORMWATER RUNOFF FROM ACCESS ROADS AND STABILISED ENTRY/EXIT POINTS MUST DRAIN TO AN APPROPRIATE SEDIMENT CONTROL DEVICE.
- ACCEPTABLE VARIATIONS TO THE ABOVE SPECIFICATION INCLUDE METAL "CATTLE" GRIDS OR SPACED TIMBER SLEEPERS AT LEAST 3.5M LONG WHICH IF USED MUST BE TO THE SATISFACTION OF THE SUPERINTENDENT.

## **EROSION RISK ASSESSMENT**

AN EROSION RISK ASSESSMENT WILL BE CONDUCTED USING THE REVISED UNIVERSAL SOIL LOSS EQUATION (RUSLE) DURING THE DETAILED DESIGN PHASE.

#### DURING DEMOLITION WORKS ALL EFFORT SHOULD BE TAKEN TO MINIMISE DISTURBANCE TO THE EXISTING UNDERLYING SOILS. PRIOR TO COMMENCING WORKS KERB INLET TRAPS SHOULD BE PLACED WITHIN

SEDIMENT CONTROL MEASURES

STORMWATER INLETS ALONG BOTH STREET FRONTAGES. A STABILISED CONSTRUCTION ENTRY/EXIT POINT SHOULD ALSO BE ESTABLISHED.

#### **BASEMENT WORKS**

**DEMOLITION WORKS** 

GIVEN THE NATURE OF WORKS FOR THE CONSTRUCTION OF THE BASEMENT AREA, IT IS EXPECTED THE MAJORITY OF THE SITE WILL DRAIN TO AND EFFECTIVELY ACT AS ONE LARGE SEDIMENT CAPTURE AREA (DURING BELOW GROUND WORKS).

PRIOR TO ANY PROPOSED PUMP-OUT OF RAINWATER FROM SITE. STORED WATER SHALL BE ASSESSED FOR QUALITY BEFORE DISCHARGING OFF SITE.

DEWATERING OF THE STORMWATER RUNOFF CAPTURED SHALL BE IN ACCORDANCE

- WITH THE DISCHARGE CRITERIA NOMINATED BELOW: TOTAL SUSPENDED SOLIDS (TSS) < 50 MG/L
- 0.3MG/L MAXIMUM TOTAL IRON CONCENTRATION
- 0.2MG/L MAXIMUM TOTAL ALUMINIUM CONCENTRATION NO VISIBLE PLUME AT EITHER THE POINT OF RELEASE FROM THE SITE OR WITHIN

SUSPENDED SEDIMENT IN CAPTURED RUNOFF MAY BE ALLOWED TO SETTLE IN-SITU WITHIN THE EXCAVATION UNTIL REACHING THE NOMINATED CRITERIA. OR IF TREATMENT IS REQUIRED, THIS CAN OCCUR IN-SITU OF BE TRANSPORTED OFFSITE FOR TREATMENT AND DISPOSAL BY A QUALIFIED CONTRACTOR.

#### ABOVE GROUND WORKS


A STABILISED CONSTRUCTION ENTRY/EXIT SHOULD BE INSTALLED (IF NOT PRIOR) AT ACCESS POINT/S AND APPROPRIATELY MAINTAINED. INLET PROTECTION FOR STORMWATER PITS/GULLYS WITHIN THE SITE AND WITHIN BOTH STREET FRONTAGES SHOULD BE INSTALLED AND APPROPRIATELY MAINTAINED. SEDIMENT FENCE SHOULD BE INSTALLED AT THE LIMIT OF GROUND DISTURBANCE DURING ABOVE GROUND WORKS UNLESS ALL EXPOSED SURFACES ARE TREATED USING TEMPORARY EROSION CONTROL OR VIA PERMANENT SURFACE TREATMENTS (LANDSCAPING, OR HARD

## **EROSION CONTROL MEASURES**

AS THE MAJORITY OF THE PROPOSED CONSTRUCTION ACTIVITIES INVOLVE THE USE OF HARD ENGINEERING MATERIALS, THIS GREATLY MINIMISES THE NEED FOR TEMPORARY EROSION CONTROL (DURING CONSTRUCTION PHASES) AND REHABILITATION (POST CONSTRUCTION). THE RELIANCE ON THESE STRUCTURAL MATERIALS AS THE DOMINANT MEASURE TO MINIMISE EROSION AND SEDIMENT DISCHARGE FROM SITE IS APPROPRIATE FOR THE WORKS.

IF TEMPORARY EROSION CONTROL IS REQUIRED IN THE INTERIM (I.E. DUE TO WORK DELAYS), THE USE OF EROSION CONTROL BLANKETS (I.E. GEOFABRIC) OR SOIL BINDER/POLYMER SHOULD BE APPLIED TO EXPOSED SURFACES.

STOCKPILES FORMED AND RETAINED ONSITE SHOULD BE LOCATED AWAY FROM STORMWATER INLETS. STOCKPILES OF EROSIVE MATERIALS SHALL BE COVERED PRIOR TO ANY FORECAST RAINFALL OR IF THEY WILL REMAIN ONSITE FOR GREATER THAN 5 DAYS.

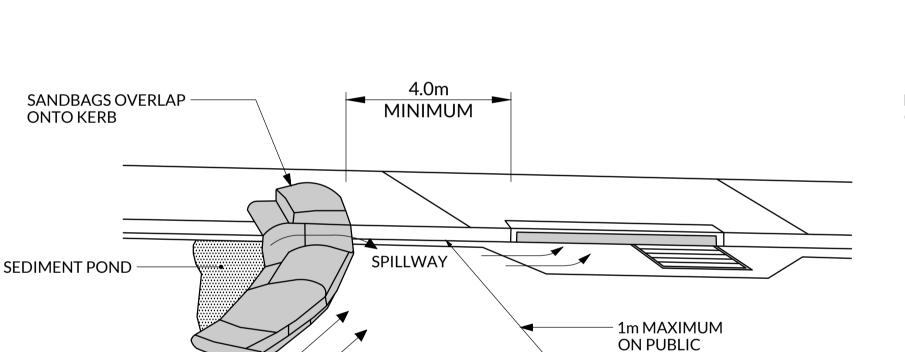

**ROADS** 

4m MINIMUM

WHEREVER PRACTICAL


# FILTER SOCKS MINIMUM **OVERLAP ONTO KERB SEDIMENT POND** 1m MAXIMUM ON PUBLIC ROADS

# **ON-GRADE KERB INLET SEDIMENT** TRAP DETAIL

SAG INLET SEDIMENT TRAP DETAIL

SCALE NTS

**SCALE NTS** 

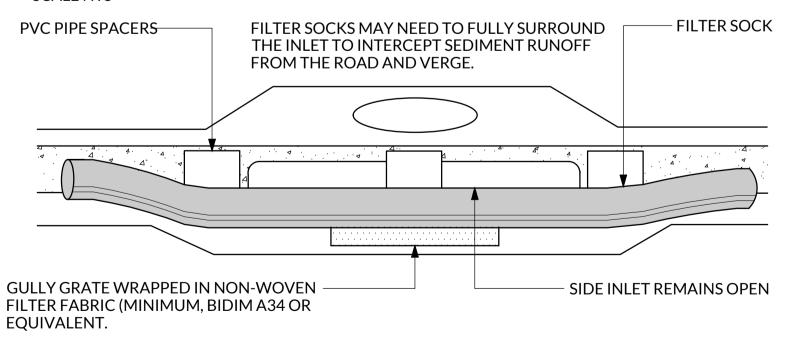

# **ON-GRADE INLET SEDIMENT** TRAPS DETAIL

- SANDBAG SEDIMENT TRAP

**ON-GRADE KERB INLET SEDIMENT** 

**COLLECTION DAM DETAIL** 

➤ OVERFLOW

**SPACING VARY** 

WITH SLOPE

**SEDIMENT-**

**SCALE NTS** 

SCALE NTS

**VERGE** 

#### BY No. DATE AMENDMENT 29.09.21 PRELIMINARY ISSUE C.R.P. B 17.12.21 DA ISSUE C.R.P. **RP DESCRIPTION**

# CLIENT: TRADERS IN PURPLE



**MRC Consulting Engineers** PO Box 778, Ashgrove West, Brisbane, QLD 4060 e:admin@mrceng.com.au, www.mrceng.com.au


**LAHC VILLAWOOD** (BUILDINGS A & C) **KAMIRA AVENUE** 

**VILLAWOOD, NSW 2163** 

# Drawn: C.R.P. **AUG 2021** Date: Designed: M.H. Checked: R.A. Approved: M.H. **FOR APPROVAL**

CPESC: 8798 **DRAWING TITLE:** 

**EROSION AND SEDIMENT CONTROL NOTES** AND DETAILS SHEET roject No. J21166 C-2.01

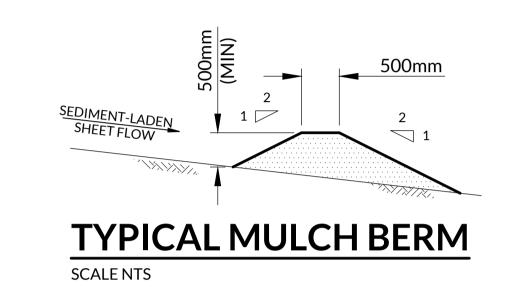


SIDE-ENTRY INLET

**ON-GRADE KERB INLET** 

**ROAD** 

- GRATE

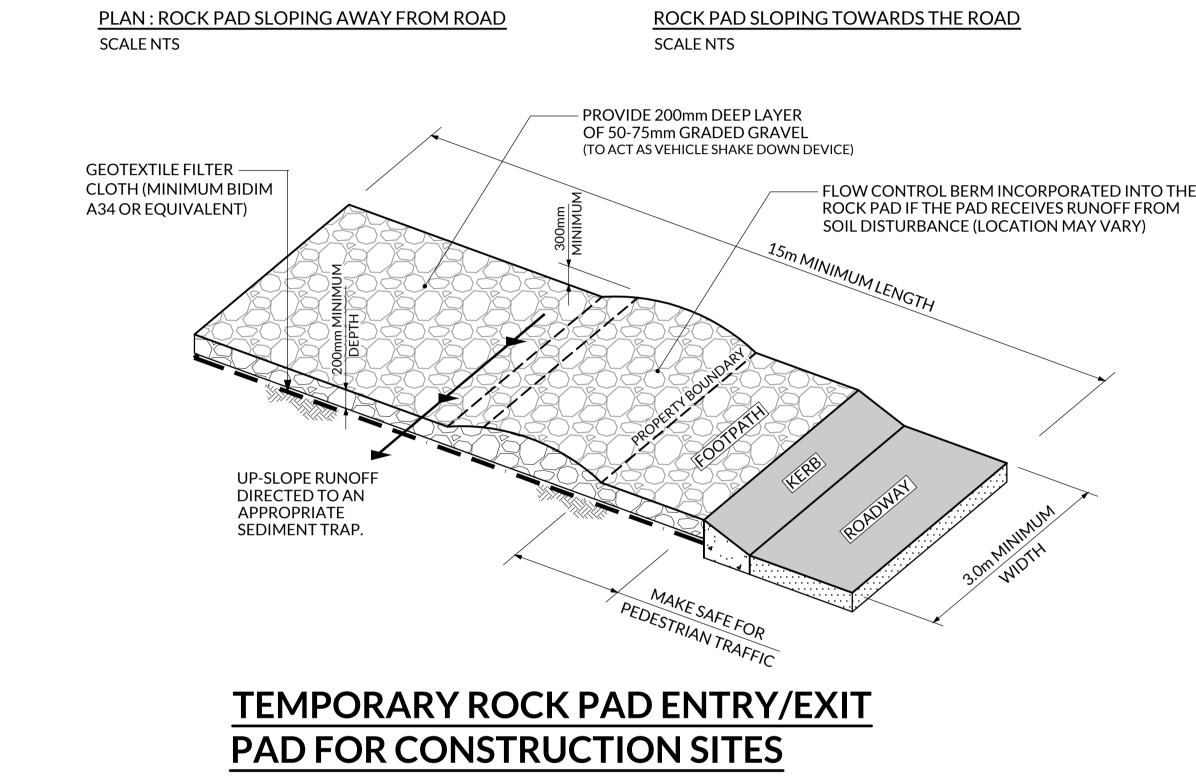


WORK SIT

**SEDIMENT** 

**FENCE** 

**FOOTPATH** 

MAKE SAFE FOR PEDESTRIAN TRAFI

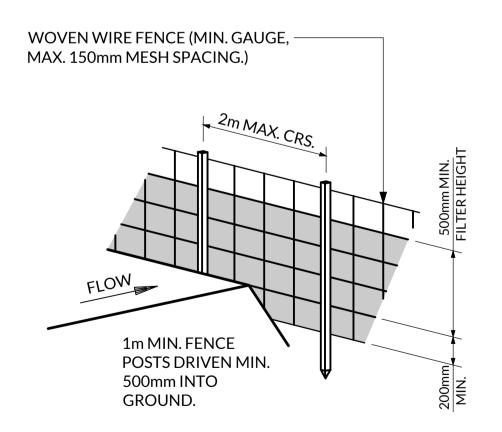

SCALE NTS

MINIMUM

ROADWAY

**WORK SITE** 

**FOOTPATH** 

**SEDIMENT FENCE PERSPECTIVE VIEW** SCALE NTS


POSTS AT 2.0m CRS. TO BE STEEL PICKETS OR 50mm x 50mm HARDWOOD. 1m APPROX. APPROVED SEDIMENT CONTROL FABRIC. TOP EDGE TO BE SUITABLY SUPPORTED BETWEEN POSTS. 200 x 200 TRENCH

**SEDIMENT FENCE DETAIL SCALE NTS** 

MINIMUM

ROADWAY

FENCE

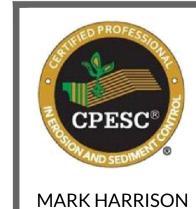

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